

### **BUILDING NOTES:**

ALL DIMENSIONS TO BE CHECKED ON SITE PRIOR TO COMMENCEMENT OF WORKS. WRITTEN DIMENSIONS TAKE PRECEDENCE OVER SCALING. THESE PLANS TO BE READ IN CONJUNCTION WITH ALL OTHER ASSOCIATED DOCUMENTS.

BUILDER TO ENSURE ALL UNDERGROUND SERVICES, PIPES AND CABLES TO BE LOCATED PRIOR TO EXCAVATION. GO TO www.byda.com.au FOR SERVICES INFORMATION.

- SITE: THE BUILDER SHALL SUPPLY/INSTALL AND MAINTAIN THE FOLLOWING IN ACCORDANCE WITH LOCAL COUNCIL AUTHORITY:
- SEDIMENT CONTROL MEASURES
- STABILISED ENTRY POINT
- CONTROLLED RUBBISH AREA
- TOILET FACILITIES

COMPLIANCE: ALL BUILDING WORK TO COMPLY WITH THE 'NATIONAL CONSTRUCTION CODE' OF AUSTRALIA, AND ANY REFERENCED AUSTRALIAN STANDARDS AND LOCAL COUNCIL AUTHORITY REQUIREMENTS.

ALL AREAS TO BE MADE GOOD BY THE BUILDER WHERE DISTURBED BY THE NEW WORK.

BASIX: BASIX - ALL SELECTIONS TO COMPLY WITH ENERGY EFFICIENCY PERFORMANCE REQUIREMENTS OF THE ASSOCIATED BASIX CERTIFICATE. CONCRETE: ALL CONCRETE SLAB & FOOTINGS FOR

CLASS 1 & 10a BUILDINGS TO COMPLY WITH AS 2870 RESIDENTIAL SLAB AND FOOTINGS. STORMWATER: DESIGN AND INSTALLATION TO COMPLY

WITH AS/NZS 3500 PLUMBING AND DRAINAGE, PART 3: STORMWATER DRAINAGE. SEWER: DESIGN AND INSTALLATION TO COMPLY WITH

AS/NZS 3500.2 PLUMBING AND DRAINAGE, PART 2: SANITARY PLUMBING AND DRAINAGE. TERMITE PROTECTION: PROVIDE PHYSICAL AND

CHEMICAL TERMITE BARRIERS IN ACCORDANCE WITH BCA VOL. 2, PART H1 STRUCTURE, H1D3 SITE PREPARATION, ABCB HOUSINGS PROVISIONS PART 3.4 TERMITE RISK MANAGEMENT AND AS 3660.1 TERMITE

MANAGEMENT PART 1: NEW RUII DING WORK

TIMBER FRAMING: FABRICATION AND INSTALLATION OF TIMBER CONSTRUCTION TO COMPLY WITH THE RELEVANT PARTS OF AS 1684 TIMBER FRAMING CODE.

MASONRY: TO BE IN ACCORDANCE WITH AS 3700:2018

MASONRY STRUCTURES.

**ELECTRICAL:** DESIGN AND INSTALLATION TO COMPLY WITH AS/NZS 3000 ELECTRICAL INSTALLATIONS.

WATERPROOFING - INTERNAL WET AREAS: TO BE IN
ACCORDANCE WITH BCA VOL. 2 PART H4 HEALTH AND
AMENITY, H4D2 WET AREAS; ABCB HOUSING
PROVISIONS PART 10.2 WET AREA WATERPROOFING.
WATERPROOFING - EXTERNAL: TO BE IN ACCORDANCE

WATERPROOFING - EXTERNAL: 10 BE IN ACCORDANCE
WITH BCA VOL. 2 PART H2 DAMP AND
WEATHERPROOFING, H2D8 EXTERNAL WATERPROOFING;
ABCB HOUSING PROVISIONS PART 10.2 WET AREA
WATERPROOFING. MATERIALS SELECTION AS PER AS
4654.1 WATERPROOFING MEMBRANES FOR EXTERNAL
ABOVE-GROUND USE, PART 1: MATERIALS. SYSTEM
DESIGN AS PER AS 4654.2 WATERPROOFING
MEMBRANES FOR EXTERNAL ABOVE-GROUND USE, PART

GLAZING: SELECTION AND INSTALLATION TO AS 2047
WINDOWS AND EXTERNAL GLAZED DOORS IN BUILDINGS
GLASS TYPE AND THICKNESS TO AS 1288 GLASS IN
BUILDINGS - SELECTION AND INSTALLATION.

2: DESIGN AND INSTALLATION

ALL OTHER COMPONENTS TO COMPLY WITH RELEVANT STANDARDS.

SMOKE DETECTORS: TO BE SELECTED, LOCATED AND INSTALLED IN ACCORDANCE WITH BCA VOL. 2, H3D6 SMOKE ALARMS AND EVACUATION LIGHTING, ABCB HOUSING PROVISIONS PART 9.5 SMOKE ALARMS AND EVACUATION LIGHTING (INCLUDING NSW STATE VARIATION) AND AS 3786 SMOKE ALARMS USING SCATTERED LIGHT, TRANSMITTED LIGHT OR IONIZATION. EXHAUST FANS: TO BE DUCTED THROUGH ROOF TO OUTSIDE TO PROVIDE MECHANICAL VENTILATION IN ACCORDANCE WITH BCA VOL. 2, H4D7 VENTILATION - CLAUSE 10.6.2 VENTILATION REQUIREMENTS AND BCA VOL. 2, H4D9 CONDENSATION MANAGEMENT; ABCB HOUSING PROVISIONS PART 10.8 CONDENSATION MANAGEMENT.

#### **BASIX NOTES:**

THESE PLANS TO READ IN CONJUNCTION WITH THE ASSOCIATED BASIX CERTIFICATE.

ALL RELEVANT FITTINGS, FIXTURES &

APPLIANCES TO COMPLY WITH OR EXCEED THE MINIMUM
REQUIREMENTS NOTED IN THE BASIX CERTIFICATE.

#### **SEWER & STORMWATER NOTE**

PLUMBING AND DRAINAGE DESIGN & INSTALLATION TO BE IN ACCORDANCE WITH NCC PLUMBING CODE OF AUSTRALIA AND AS/NZS 3500 PLUMBING AND DRAINAGE PARTS 0,1,2,3 & 4. PLUMBING CONTRACTOR SHALL ENSURE THE DESIGN

AND INSTALLATION IS IN COMPLIANCE WITH THE ABOVE AND SHALL LOCATE ALL BOUNDARY RISERS & MAINS SPURS PRIOR TO COMMENCEMENT OF WORK.

CONNECT NEW SEWER & STORMWATER PIPE SYSTEM TO EXISTING COUNCIL MAINS SYSTEM.

OR CONNECT TO NEW OR EXISTING ON-SITE SEWER TREATMENT SYSTEM.

#### CUT & FILL NOTE:

ALL CUT & FILL LEVELS TO BE CHECKED ON SITE BY BUILDING CONTRACTOR PRIOR TO EXCAVATION.

# STAIRWAYS, RAMPS, BARRIERS

& HANDRAILS NOTE

STAIRWAYS AND RAMPS TO BE CONSTRUCTED IN ACCORDANCE WITH BCA VOL. 2, PART 5 SAFE MOVEMENT AND ACCESS, H5D2 STAIRWAY AND RAMP CONSTRUCTION, ABCB HOUSING PROVISIONS PART 11.2 STAIRWAY AND RAMP CONSTRUCTION.

BARRIERS AND HANDRAILS TO BE CONSTRUCTED IN ACCORDANCE WITH BCA VOL. 2, PART 5 SAFE MOVEMENT AND ACCESS, H5D3 BARRIERS AND HANDRAILS, ABCB HOUSING PROVISIONS PART 11.3 BARRIERS AND HANDRAILS.

GOINGS - UNLESS NOTED OTHERWISE - 280
RISERS - 115 MIN. 190 MAX. BUILDING CONTRACTOR TO
CHECK FINISHED LEVELS ON SITE TO ENSURE ALL
RISERS ARE EQUAL.

THIS DRAWING IS TO BE READ IN CONJUNCTION WITH ALL DRAWINGS AND SPECIFICATIONS RELATING TO THIS PROJECT. REFER SHEET A01 FOR BUILDING NOTES.

#### AMBIGUITY, ERROR OR OMISSION NOTE

'IF IN DOUBT, ASK: IF IT DOESN'T LOOK RIGHT, QUESTION I

ANY PERSON INVOLVED WITH THIS PROJECT (CONSULTANT, CONTRACTOR, SUB-CONTRACTOR, AUTHORITY, SUPPLIER, OWNER AND THE LIKE) THAT DISCOVERS ANY AMBIGUITY, ERROR OR OMISSION IN THESE DOCUMENTS, OR BETWEEN THESE DOCUMENTS AND ANY OTHER RELEVANT DOCUMENTS (CONSULTANT'S PLANS, REPORTS, DCP, LEP, BCA, AUSTRALIAN STANDARDS OR THE LIKE), SHALL ADVISE ROBERSON CONSTRUCTIONS IMMEDIATELY AND SEEK CLARIFICATION. NO DECISIONS WITH REGARD TO APPROVAL, PRICING, SUPPLY OR CONSTRUCTION ARE TO BE MADE WITH RESPECT TO THE ISSUE WITHOUT WRITTEN APPROVAL OR UPDATED DOCUMENTATION TO CORRECT THIS AMBIGUITY ERROR OR OMISSION.

#### **WORKPLACE HEALTH & SAFETY**

DURING CONSTRUCTION AND THE ON GOING
MAINTENANCE OF THIS BUILDING ENSURE WORKPLACE
HEALTH AND SAFETY IS FULLY UNDERSTOOD AND
IMPLEMENTED BY ALL PERSONS INVOLVED WITH THIS
JOB.

REFER TO THE PRELIMINARIES WORKSECTION IN THE SPECIFICATION FOR THE EXPLANATIONS OF THE 10 KEY AREAS OF INFLUENCE. THESE AREAS ARE AS FOLLOWED:


FALLS, SLIPS AND TRIPS,
FALLING OBJECTS,
TRAFFIC MANAGEMENT,

- MANUAL TASKS, - HAZARDOUS SUBSTANCES,

- SERVICES,

- CONFINED SPACES,
- PUBLIC ACCESS,
- OPERATION USE OF BUILDING RESIDENTIAL

BUILDINGS, - OTHER HIGH RISK ACTIVITY.

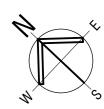

# PRELIMINARY NOT FOR CONSTRUCTION





Drafted by K. McMullen, ph 0414737188

Projec


PROPOSED NEW UNIT DEVELOPMENT LOT 144 DP 1281496 107 LINGIARI DRIVE, LLOYD


Client

ROBERSON CONSTRUCTIONS

heet Title
SITE & SITE ANALYSIS PLAN

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morrisons.

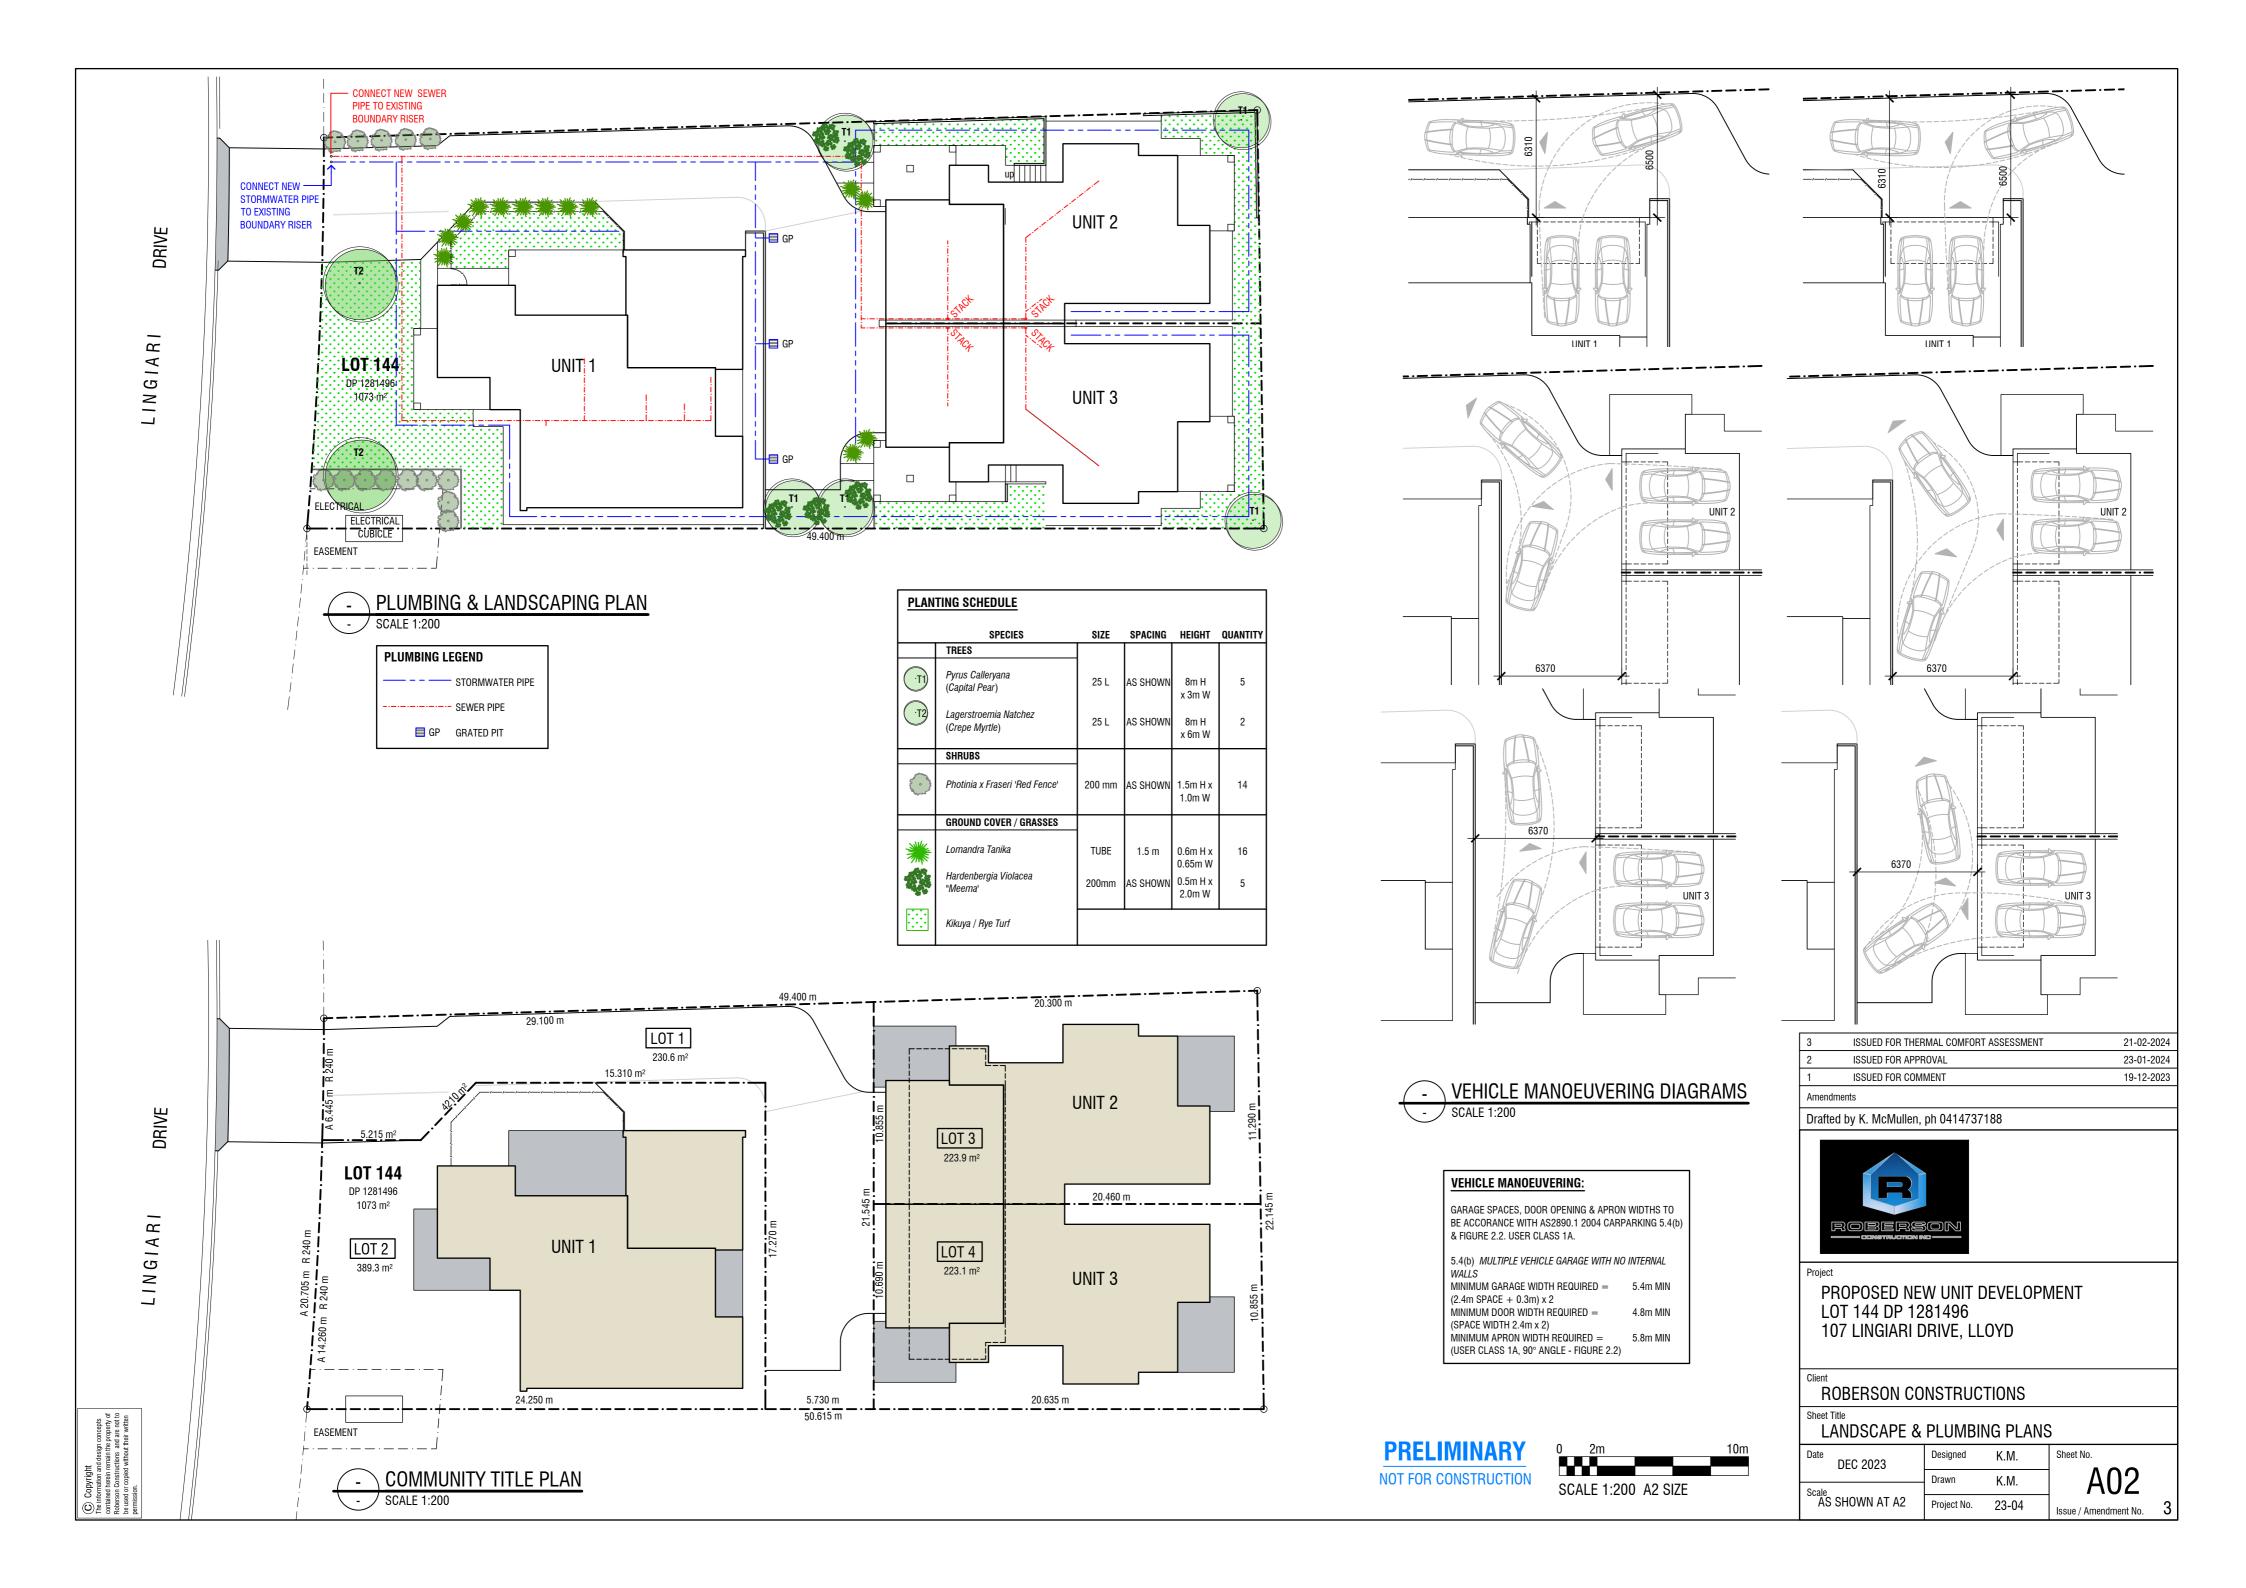

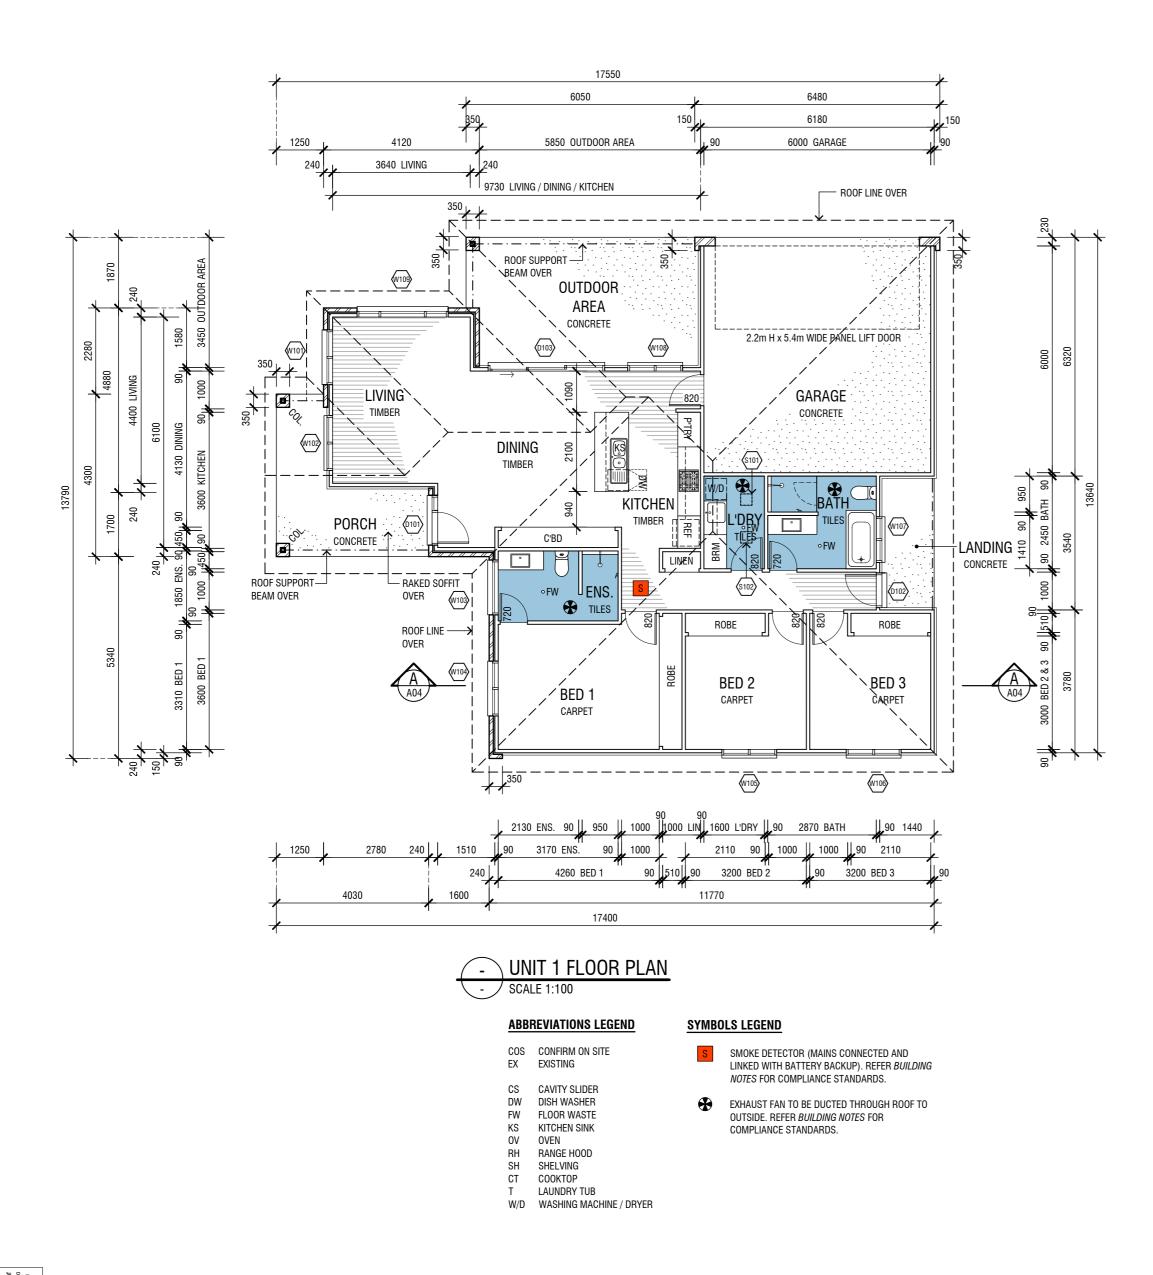

# WINDOW & DOOR SCHEDULE - UNIT 1

No.	SIZE (H x W)	GLAZING (m	2) DESCRIPTION
W101	1500 x 1450	2.18 m <sup>2</sup>	ALUMINIUM FRAMED SLIDING WINDOW, DG
W102	1500 x 1450	2.18 m <sup>2</sup>	ALUMINIUM FRAMED SLIDING WINDOW, DG
W103	600 x 1450	0.87 m <sup>2</sup>	ALUMINIUM FRAMED AWNING WINDOW, DG, SAF
W104	1500 x 1450	2.18 m <sup>2</sup>	ALUMINIUM FRAMED SLIDING WINDOW, DG
W105	1200 x 1450	1.74 m <sup>2</sup>	ALUMINIUM FRAMED SLIDING WINDOW, DG
W106	1200 x 1450	1.74 m <sup>2</sup>	ALUMINIUM FRAMED SLIDING WINDOW, DG
W107	900 x 1210	1.09 m <sup>2</sup>	ALUMINIUM FRAMED SLIDING WINDOW, DG, OB, SAF
W108	1500 x 1450	2.18 m <sup>2</sup>	ALUMINIUM FRAMED SLIDING WINDOW, DG
W109	1500 x 2410	3.62 m <sup>2</sup>	ALUMINIUM FRAMED SLIDING WINDOW, DG
D101	0100 1000	0.052	TIMBER FRAMER OOG ENTRY ROOF WITH CIRCUIT DO
D101	2100 x 1320	0.95 m <sup>2</sup>	TIMBER FRAMED 820 ENTRY DOOR WITH SIDELIGHT, DG
D102	2100 x 920	- m <sup>2</sup>	TIMBER FRAMED 820 SOLID CORE DOOR
D103	2100 x 3010	6.32 m <sup>2</sup>	ALUMINIUM FRAMED GLASS SLIDING DOOR, DG
S101 - S1	102	-	SUN TUNNEL WITH SQUARE FROSTED GLASS DIFFUSER.

- GLAZING AND WINDOW SELECTION AND INSTALLATION TO AS 2047 WINDOWS AND EXTERNAL GLAZED DOORS IN BUILDINGS AND AS 1288 GLASS IN BUILDINGS - SELECTION AND INSTALLATION. - WINDOW FRAME AND GLAZING PERFORMANCE LEVELS TO MEET OR EXCEED BASIX CERTIFICATE
- REQUIREMENTS.
- BUILDER TO ADVISE FRAMING MANUFACTURER OF SELECTED WINDOW MANUFACTURER'S SIZES AS STANDARD WINDOW SIZES VARY SLIGHTLY BETWEEN MANUFACTURER'S.
- ALL WINDOW & DOOR DIMENSIONS TO BE CHECKED ON SITE PRIOR TO FABRICATION.
- ALL WINDOW AND DOOR HEAD HEIGHT, UNLESS NOTED OTHERWISE 2100. - ALL OPERABLE WINDOWS TO BE FITTED WITH SEALS AND TIGHT FITTING FLY SCREENS.
- EXTERNAL DOORS TO BE FITTED WITH WEATHER SEALS ALL ROUND.
- FIRST FLOOR AND OVER BEDROOM WINDOWS TO HAVE RESTRICTED OR PROTECTED OPENING AS PER BCA VOL. 2 PART H5 SAFE MOVEMENT AND ACCESS, H5D3 BARRIERS AND HANDRAILS, ABCB HOUSING PROVISIONS PART 11.3 BARRIERS AND HANDRAILS, CLAUSE 11.3.7 PROTECTION OF OPENABLE WINDOWS - BEDROOMS.

HH - HEAD HEIGHT DG - DOUBLE GLAZED

- FR FROSTED GLASS
- OB OBSCURE GLASS
- SAF SAFETY GLASS
- RES RESTRICTED/PROTECTED OPENING
- MOT MOTORISED WINDOW

# **PRELIMINARY** NOT FOR CONSTRUCTION





SCALE 1:100 A2 SIZE

3	ISSUED FOR THERMAL COMFORT ASSESSMENT	21-02-2024
2	ISSUED FOR APPROVAL	23-01-2024
1	ISSUED FOR COMMENT	19-12-2023

## Drafted by K. McMullen, ph 0414737188




PROPOSED NEW UNIT DEVELOPMENT LOT 144 DP 1281496 107 LINGIARI DRIVE. LLOYD


ROBERSON CONSTRUCTIONS

FLOOR PLAN - UNIT 1

ILOUITILAN	OIVII I		
Date DFC 2023	Designed	K.M.	Sheet No.
510 2020	Drawn	K.M.	A03
Scale AS SHOWN AT A2	Project No.	23-04	Issue / Amendment No.

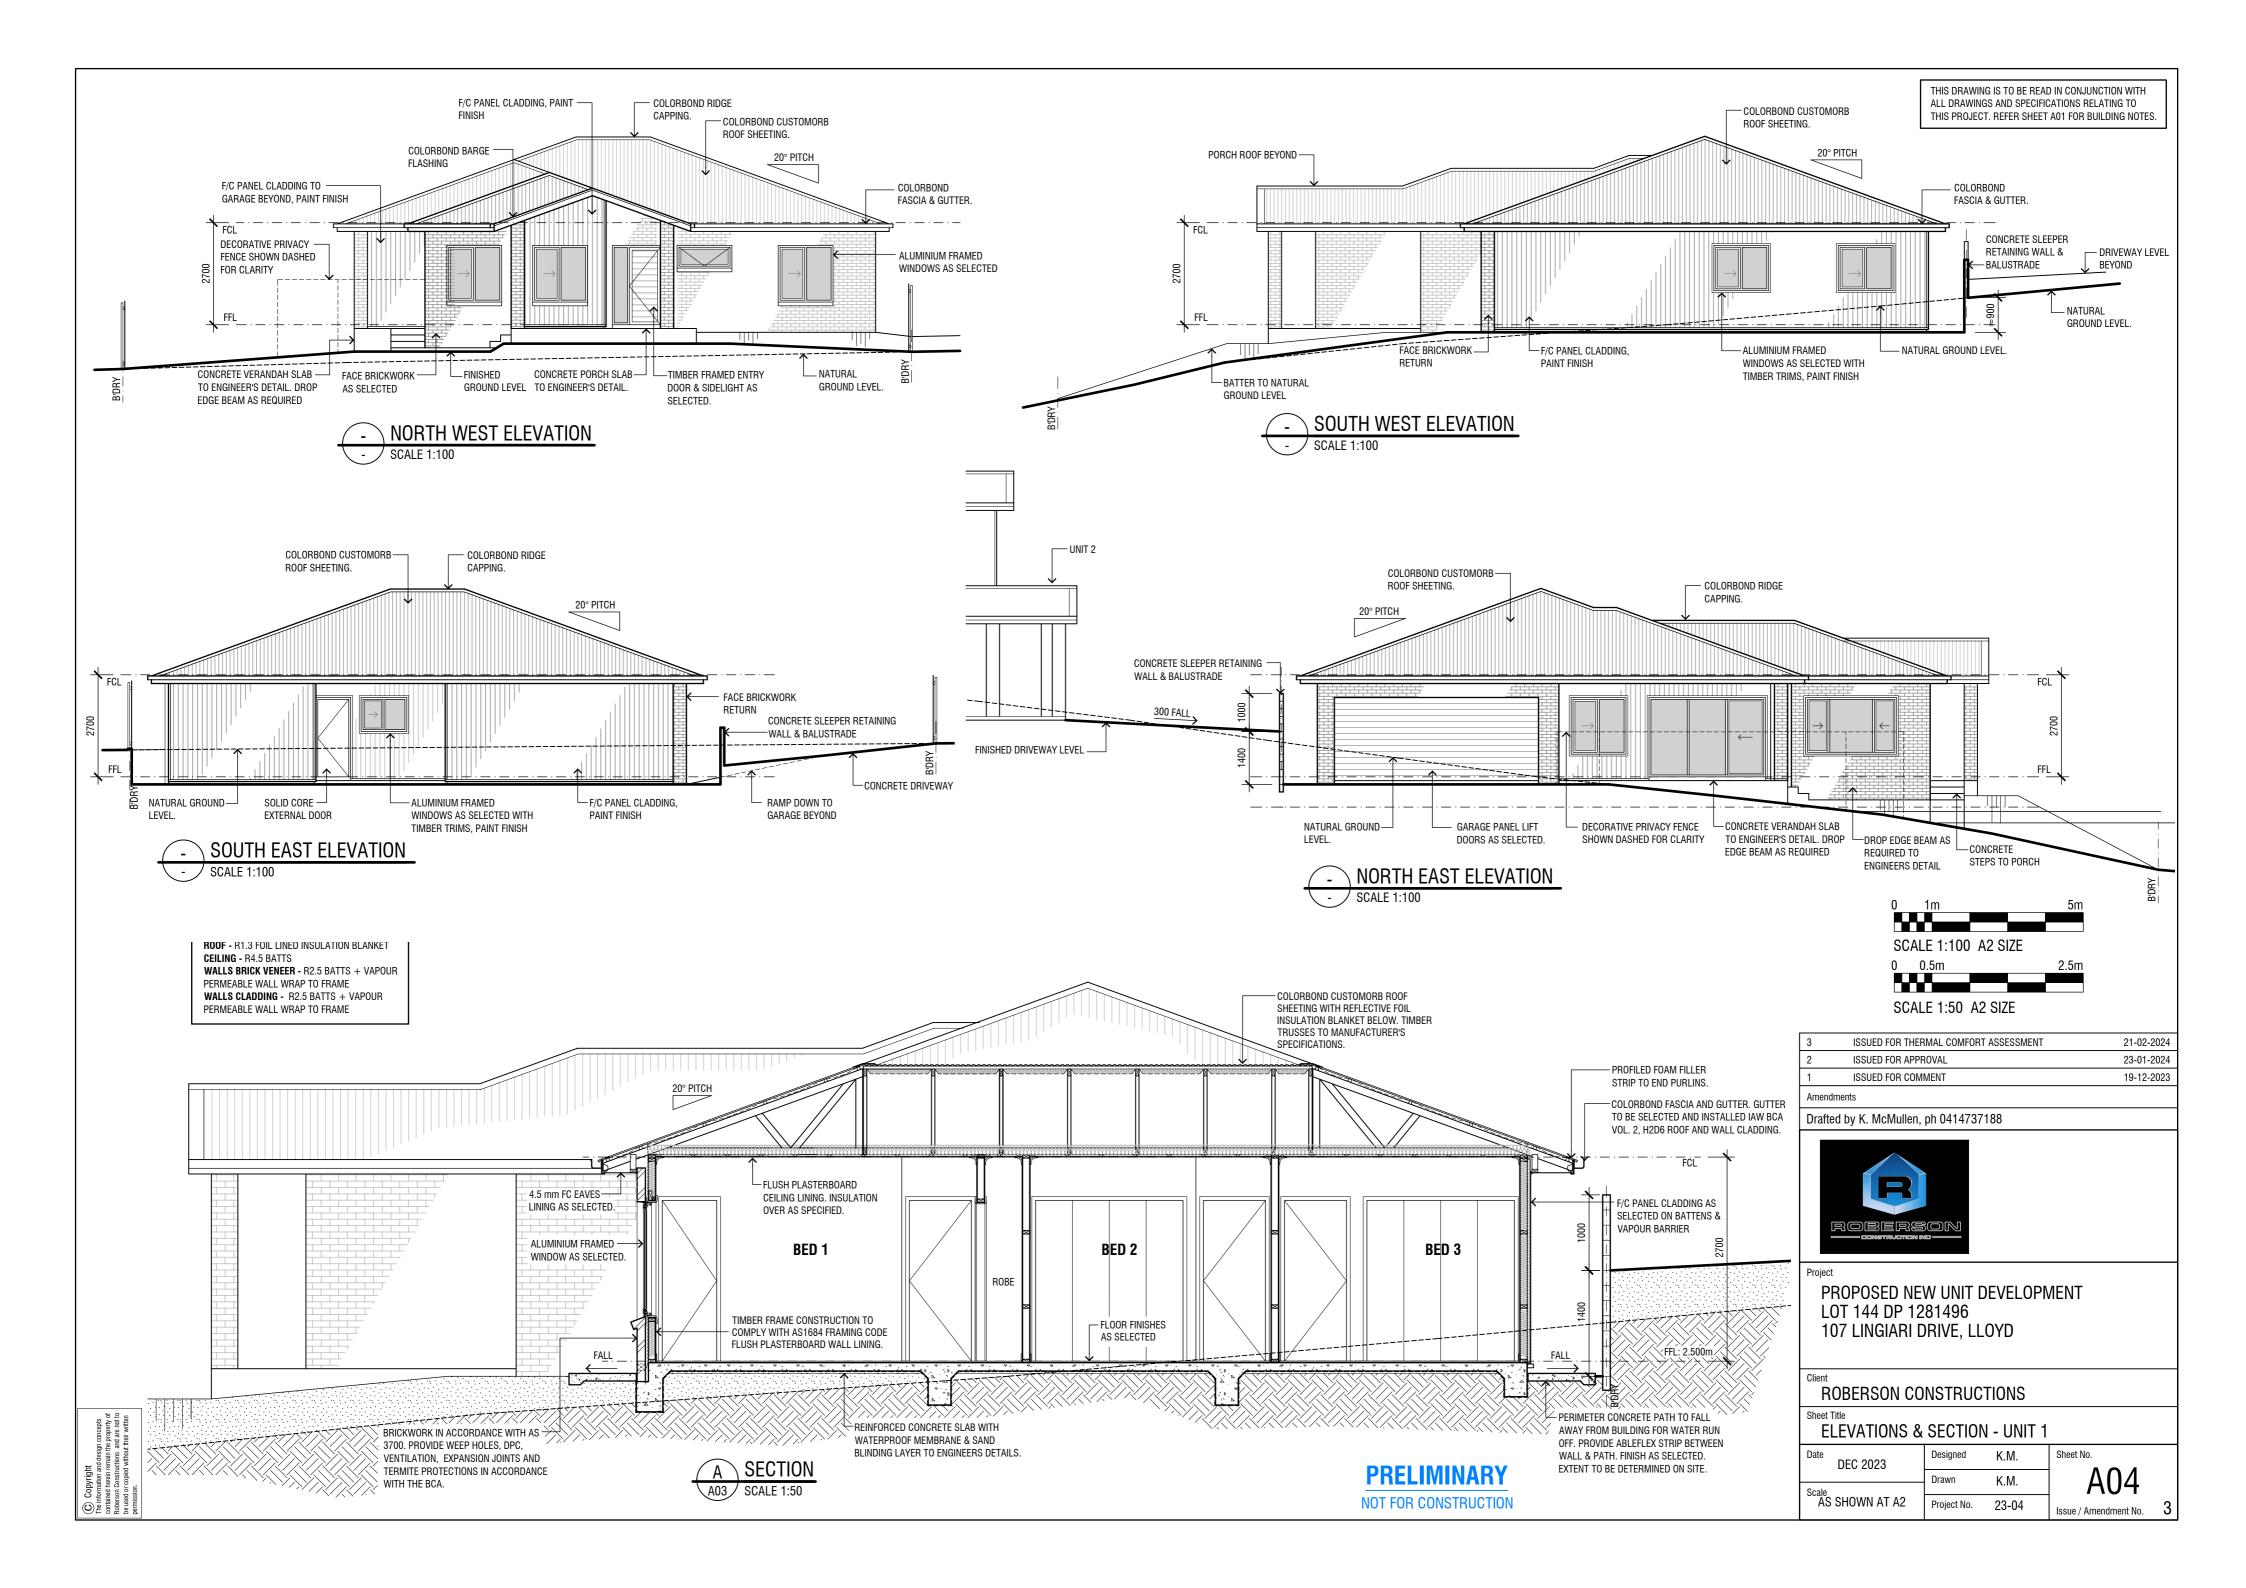

THIS DRAWING IS TO BE READ IN CONJUNCTION WITH ALL DRAWINGS AND SPECIFICATIONS RELATING TO THIS PROJECT. REFER SHEET A01 FOR BUILDING NOTES.

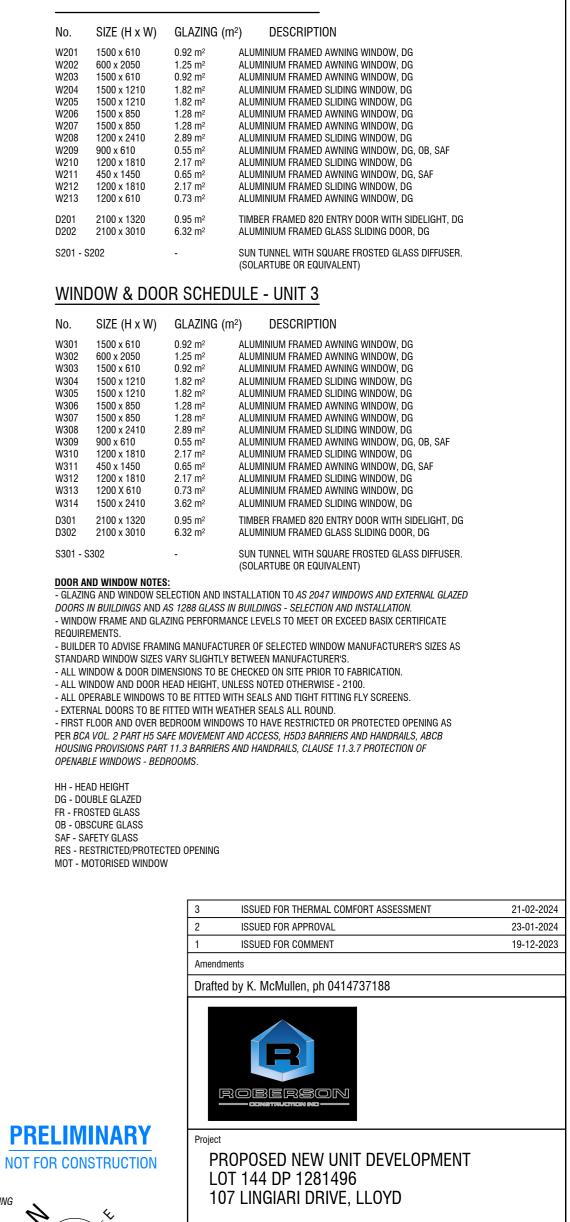



SMOKE DETECTOR (MAINS CONNECTED AND LINKED WITH BATTERY BACKUP). REFER BUILDING NOTES FOR COMPLIANCE STANDARDS.

OUTSIDE. REFER BUILDING NOTES FOR COMPLIANCE STANDARDS.

EXHAUST FAN TO BE DUCTED THROUGH ROOF TO

SCALE 1:100 A2 SIZE

ROBERSON CONSTRUCTIONS

GROUND FLOOR PLAN - UNITS 2 & 3 K.M. Designed

DEC 2023 A05 Drawn K.M. Scale AS SHOWN AT A2 Project No. 23-04 Issue / Amendment No.



19080

3190 ENTRY 1680 (6 TREADS @ 280)

TILES

ENS.

TILES

950 2010

2060 L'DRY

2240 (8 TREADS @ 28) 168**0** (6 TREADS @ 280)

980050 WIR

900

19080

2240 (8 TREADS @ 28)

2060 L'DRY 90<sub>1</sub>

3050 WIR

3820 KITCHEN

LINEN

BED 1

BED 1

CARPET

FINEK

TIMBER

3290 BED 1

2210 LIN

3820 KITCHEN

4000

6880 KITCHEN / DINING

. 1000 |

90 2210 LIN ملا

6880 KITCHEN / DINING |

3360

-RAKED SOFFIT OVER

PORCH

FLOOR OVER

FIRE/ACOUSTIC WALL

ROOF LINE

**OVER** 

REFER TO DETAIL

SHEET A08

CONCRETE (D201)

**ENTRY** 

TIMBER

GARAGE

CONCRETE

COLUMNS &

GARAGE

CONCRETE

PORCH

3503360

4350

SCALE 1:100

6000 GARAGE

UNITS 2 & 3 GROUND FLOOR PLAN

**ENTRY** 

1590 JENTRY

OVER TO

SUPPORT BEAM

ENGINEERS DETAIL

1900 240

6000 GARAGE

3000

1300

OUTDOOR!

·/AREA

CONCRETE

- ROOF SUPPORT BEAM OVER

EXTERNAL STAIR WALL

EXTERNAL STAIR WALL

ABBREVIATIONS LEGEND

COS CONFIRM ON SITE

CAVITY SLIDER

DISH WASHER

FLOOR WASTE

KITCHEN SINK

OVEN RANGE HOOD

SHELVING

COOKTOP

LAUNDRY TUB

W/D WASHING MACHINE / DRYER

EX EXISTING

CS

DW

FW

SH

CT

1700

4200 LIVING

**ROOF LINE OVER** 

DINING

LIVING

TIMBER

UNIT 2

W314

UNIT 3

LIVING

TIMBER

DINING

TIMBER

4200 LIVING

1700

3000

<sup>90</sup>2070

W305

≺ÓUTDOOR

`AREA

CONCRETE

# WINDOW & DOOR SCHEDULE - UNIT 2

No.	SIZE (H x W)	GLAZING (m	<sup>2</sup> ) DESCRIPTION
W201	1500 x 610	0.92 m <sup>2</sup>	ALUMINIUM FRAMED AWNING WINDOW, DG
W202	600 x 2050	1.25 m <sup>2</sup>	ALUMINIUM FRAMED AWNING WINDOW, DG
W203	1500 x 610	0.92 m <sup>2</sup>	ALUMINIUM FRAMED AWNING WINDOW, DG
W204	1500 x 1210	1.82 m <sup>2</sup>	ALUMINIUM FRAMED SLIDING WINDOW, DG
W205	1500 x 1210	1.82 m <sup>2</sup>	ALUMINIUM FRAMED SLIDING WINDOW, DG
W206	1500 x 850	1.28 m <sup>2</sup>	ALUMINIUM FRAMED AWNING WINDOW, DG
W207	1500 x 850	1.28 m <sup>2</sup>	ALUMINIUM FRAMED AWNING WINDOW, DG
W208	1200 x 2410	2.89 m <sup>2</sup>	ALUMINIUM FRAMED SLIDING WINDOW, DG
W209	900 x 610	0.55 m <sup>2</sup>	ALUMINIUM FRAMED AWNING WINDOW, DG, OB, SAF
W210	1200 x 1810	2.17 m <sup>2</sup>	ALUMINIUM FRAMED SLIDING WINDOW, DG
W211	450 x 1450	0.65 m <sup>2</sup>	ALUMINIUM FRAMED AWNING WINDOW, DG, SAF
W212	1200 x 1810	2.17 m <sup>2</sup>	ALUMINIUM FRAMED SLIDING WINDOW, DG
W213	1200 x 610	0.73 m <sup>2</sup>	ALUMINIUM FRAMED AWNING WINDOW, DG
D201	2100 x 1320	0.95 m <sup>2</sup>	TIMBER FRAMED 820 ENTRY DOOR WITH SIDELIGHT, DG
D201 D202	2100 x 1320 2100 x 3010	6.32 m <sup>2</sup>	•
DZUZ	2100 X 3010	0.32 1112	ALUMINIUM FRAMED GLASS SLIDING DOOR, DG
S201 - S202		-	SUN TUNNEL WITH SQUARE FROSTED GLASS DIFFUSER. (SOLARTUBE OR EQUIVALENT)

# WINDOW & DOOR SCHEDULE - UNIT 3

No.	SIZE (H x W)	GLAZING (m	2) DESCRIPTION
W301	1500 x 610	0.92 m <sup>2</sup>	ALUMINIUM FRAMED AWNING WINDOW, DG
W302	600 x 2050	1.25 m <sup>2</sup>	ALUMINIUM FRAMED AWNING WINDOW, DG
W303	1500 x 610	0.92 m <sup>2</sup>	ALUMINIUM FRAMED AWNING WINDOW, DG
W304	1500 x 1210	1.82 m <sup>2</sup>	ALUMINIUM FRAMED SLIDING WINDOW, DG
W305	1500 x 1210	1.82 m <sup>2</sup>	ALUMINIUM FRAMED SLIDING WINDOW, DG
W306	1500 x 850	1.28 m <sup>2</sup>	ALUMINIUM FRAMED AWNING WINDOW, DG
W307	1500 x 850	1.28 m <sup>2</sup>	ALUMINIUM FRAMED AWNING WINDOW, DG
W308	1200 x 2410	2.89 m <sup>2</sup>	ALUMINIUM FRAMED SLIDING WINDOW, DG
W309	900 x 610	0.55 m <sup>2</sup>	ALUMINIUM FRAMED AWNING WINDOW, DG, OB, SAF
W310	1200 x 1810	2.17 m <sup>2</sup>	ALUMINIUM FRAMED SLIDING WINDOW, DG
W311	450 x 1450	0.65 m <sup>2</sup>	ALUMINIUM FRAMED AWNING WINDOW, DG, SAF
W312	1200 x 1810	2.17 m <sup>2</sup>	ALUMINIUM FRAMED SLIDING WINDOW, DG
W313	1200 X 610	0.73 m <sup>2</sup>	ALUMINIUM FRAMED AWNING WINDOW, DG
W314	1500 x 2410	3.62 m <sup>2</sup>	ALUMINIUM FRAMED SLIDING WINDOW, DG
D301	2100 x 1320	0.95 m <sup>2</sup>	TIMBER FRAMED 820 ENTRY DOOR WITH SIDELIGHT, DG
D302	2100 x 3010	6.32 m <sup>2</sup>	ALUMINIUM FRAMED GLASS SLIDING DOOR, DG
S301 - S3	302	-	SUN TUNNEL WITH SQUARE FROSTED GLASS DIFFUSER.

#### DOOR AND WINDOW NOTES:

- GLAZING AND WINDOW SELECTION AND INSTALLATION TO AS 2047 WINDOWS AND EXTERNAL GLAZED DOORS IN BUILDINGS AND AS 1288 GLASS IN BUILDINGS - SELECTION AND INSTALLATION. - WINDOW FRAME AND GLAZING PERFORMANCE LEVELS TO MEET OR EXCEED BASIX CERTIFICATE REQUIREMENTS.

- BUILDER TO ADVISE FRAMING MANUFACTURER OF SELECTED WINDOW MANUFACTURER'S SIZES AS

(SOLARTUBE OR EQUIVALENT)

STANDARD WINDOW SIZES VARY SLIGHTLY BETWEEN MANUFACTURER'S. - ALL WINDOW & DOOR DIMENSIONS TO BE CHECKED ON SITE PRIOR TO FABRICATION.

- ALL WINDOW AND DOOR HEAD HEIGHT, UNLESS NOTED OTHERWISE - 2100.

- ALL OPERABLE WINDOWS TO BE FITTED WITH SEALS AND TIGHT FITTING FLY SCREENS.

- EXTERNAL DOORS TO BE FITTED WITH WEATHER SEALS ALL ROUND. - FIRST FLOOR AND OVER BEDROOM WINDOWS TO HAVE RESTRICTED OR PROTECTED OPENING AS PER BCA VOL. 2 PART H5 SAFE MOVEMENT AND ACCESS, H5D3 BARRIERS AND HANDRAILS, ABCB HOUSING PROVISIONS PART 11.3 BARRIERS AND HANDRAILS, CLAUSE 11.3.7 PROTECTION OF

HH - HEAD HEIGHT

DG - DOUBLE GLAZED


FR - FROSTED GLASS OB - OBSCURE GLASS

SAF - SAFETY GLASS

RES - RESTRICTED/PROTECTED OPENING

OPENABLE WINDOWS - BEDROOMS.

MOT - MOTORISED WINDOW

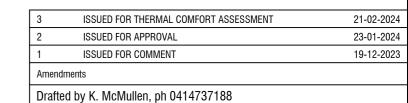




PROPOSED NEW UNIT DEVELOPMENT LOT 144 DP 1281496 107 LINGIARI DRIVE. LLOYD

ROBERSON CONSTRUCTIONS

Sheet Title EIDCT EI OOD DI AN LINITO 2 8 2

FIRST FLOUR PLAIN - UNITS 2 & 3				
Date DFC 2023	Designed	K.M.	Sheet No.	
DL0 2020	Drawn	K.M.	A06	
Scale		IX.IVI.	HUU	
AS SHOWN AT A2	Project No.	23-04	Iccus / Amendment No	

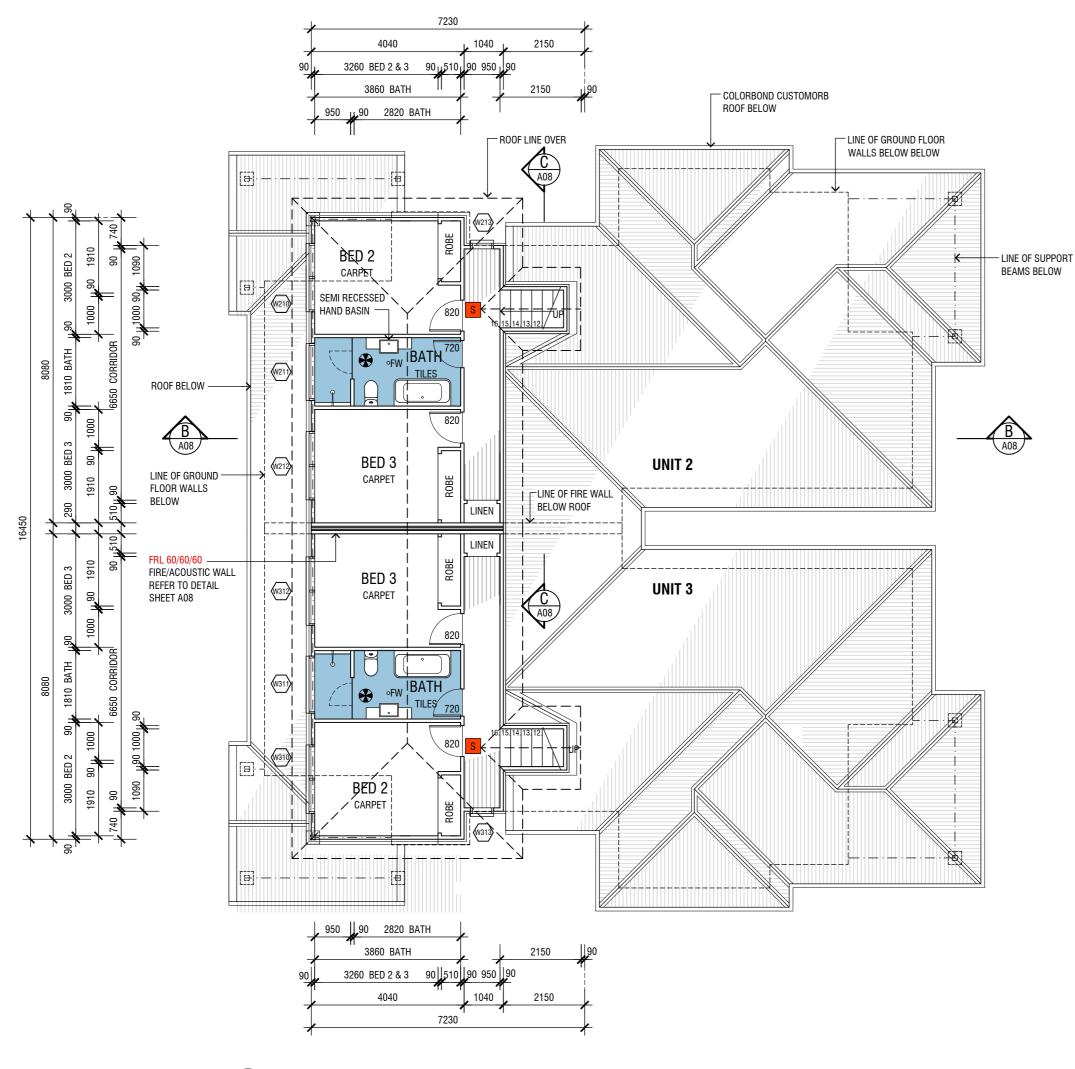

UNITS 2 & 3 FIRST FLOOR PLAN SCALE 1:100

# **ABBREVIATIONS LEGEND**

COS CONFIRM ON SITE

EX EXISTING CS CAVITY SLIDER

DW DISH WASHER FW FLOOR WASTE KITCHEN SINK

OV OVEN RANGE HOOD

SHELVING CT COOKTOP

S SMOKE DETECTOR (MAINS CONNECTED AND LINKED WITH BATTERY BACKUP). REFER BUILDING NOTES FOR COMPLIANCE STANDARDS.

SYMBOLS LEGEND

EXHAUST FAN TO BE DUCTED THROUGH ROOF TO OUTSIDE. REFER BUILDING NOTES FOR COMPLIANCE STANDARDS.

LAUNDRY TUB W/D WASHING MACHINE / DRYER **PRELIMINARY** NOT FOR CONSTRUCTION



